

March 30, 2023

Jorge E Vergara
DaRam Engineers, Inc.
11000 Richmond Ave. Suite 300
Houston, Texas 77042

Re: On-Going Services

Drainage Review of 25 Windermere – New Pool, First Revision, Third Submittal

Piney Point Village, Texas HDR Job No. 10361768

Dear Mr. Vergara:

We are in receipt of the proposed drainage plan for the above referenced address, with engineer seal dated 3/22/2023. Please make the following changes to the drainage plan:

- 1. Per City drainage criteria and our letters dated 2/22/23 and 3/15/23, the drainage system must include a clean-out, inlet, or junction box at every bend so as to provide access for maintenance; the only exception may be where roof drains tie into the main system. It appears there are several locations of proposed bends in the pipe that do not have a clean-out, inlet, or junction box at the bend or on the upstream bend of a pair of bends in pipe. Please revise the drainage plan to ensure this criterion is met.
- 2. Per City drainage criteria and our letters dated 2/22/23 and 3/15/23, all proposed drainage pipes shall be sloped to achieve a velocity of at least 3ft/sec. Based on flowline elevations, it appears that there are eight proposed pipes that are not adequately sloped to achieve a velocity of at least 3ft/sec. Please revise the drainage plan to ensure that all proposed pipes are sloped for a velocity of at least 3 ft/sec to ensure this criterion is met.
- 3. Per City drainage criteria and our letter dated 3/15/23, if storm sewer pipes are proposed in drainage plan, main pipes shall be minimum 6" PVC SDR 26. It appears that the 4-inch outfall pipes on the property are proposed to be Schedule 40. Please revise the drainage plan to ensure this criterion is met.
- 4. It appears that the proposed pool, spa, and deck cross section shows elevations that do not match the proposed pool, spa, and deck elevations shown on the drainage plan. Please verify the correct proposed elevations and revise the drainage plan so that the proposed elevations on the cross section match the elevations proposed on the drainage plan.

5. It appears that the "Proposed Curb Cut & Repair Detail @ Single Pipe Outfall" detail on the drainage plan shows two 4-inch pipes outfalling through the curb into the street while the drawing shows one location with three 4-inch pipes and another location with four 4-inch pipes outfalling into the street. Please revise the detail on the drainage plan to reflect the actual number of 4-inch pipes at each outfall location into the street.

Please revise plans and resubmit as an electronic drainage submission by email to Annette Arriaga at bldgofficial@pineypt.org. A copy of the drainage plan with markups will be sent with this letter by the Building Official. If you have any questions, please feel free to contact the City.

Sincerely,


HDR Engineering, Inc.


Aaron Croley, P.E., CFM


Moron Croby

Project Engineer


Cc: Annette Arriaga – City of Piney Point Village

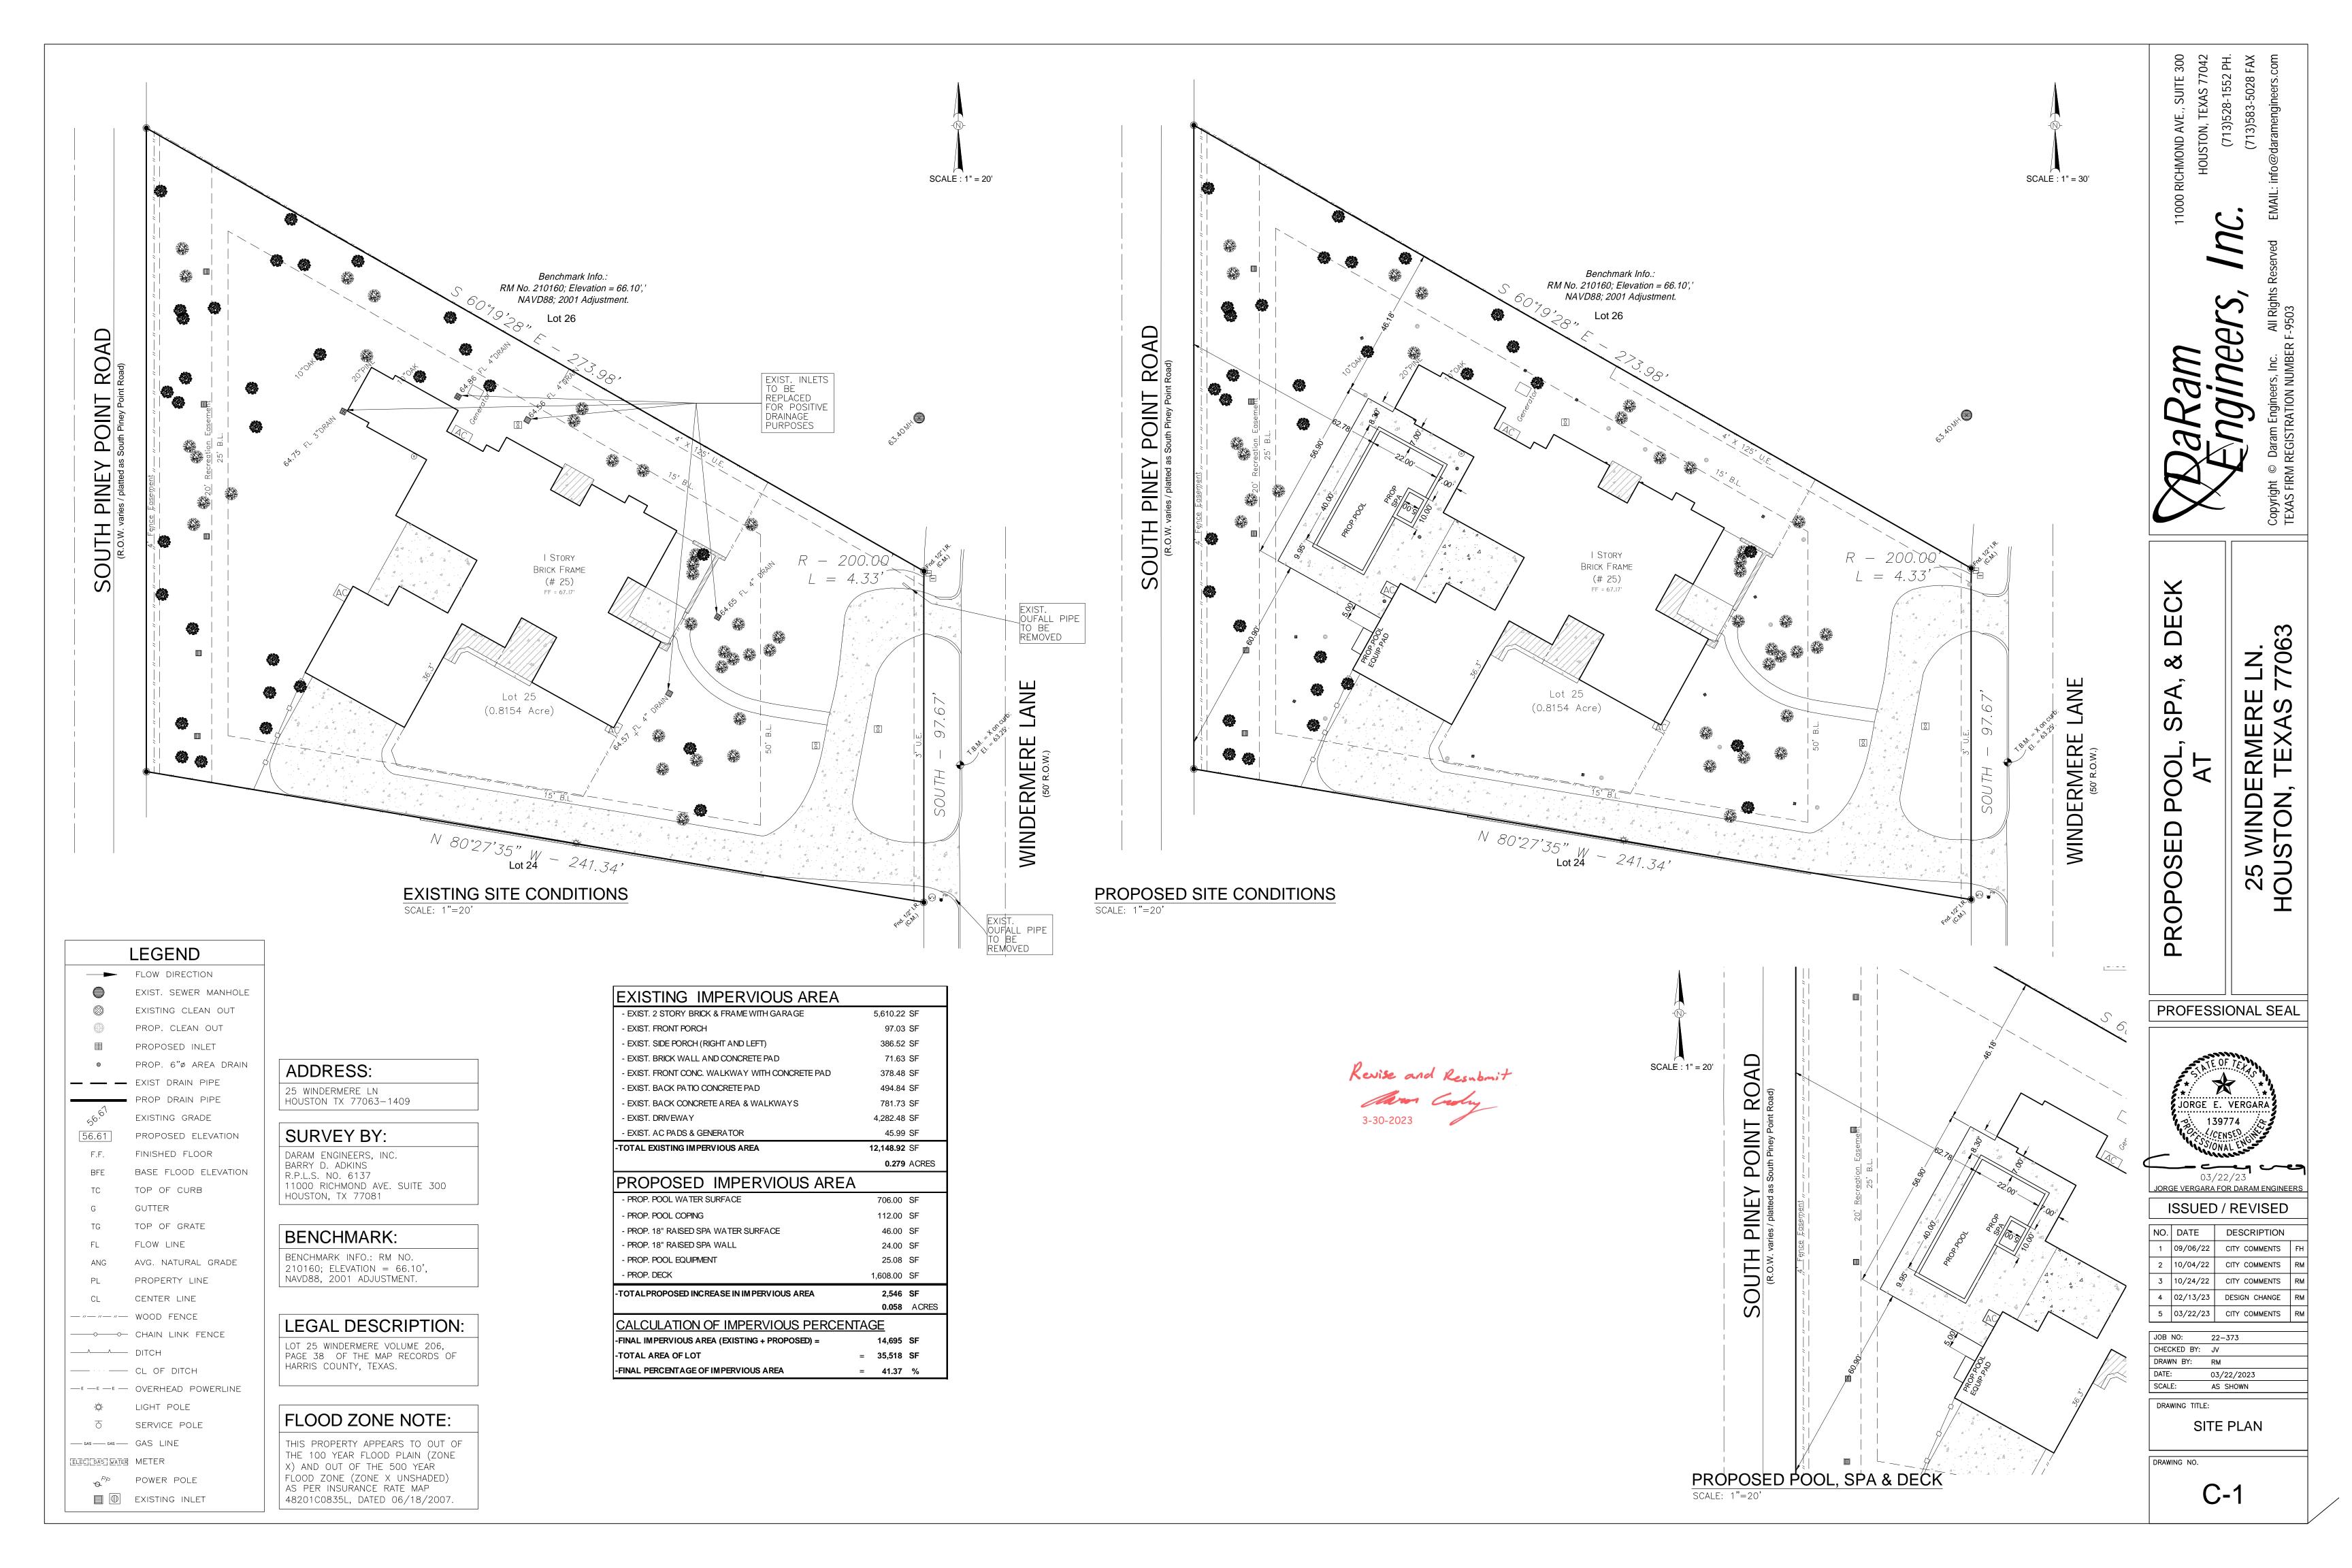

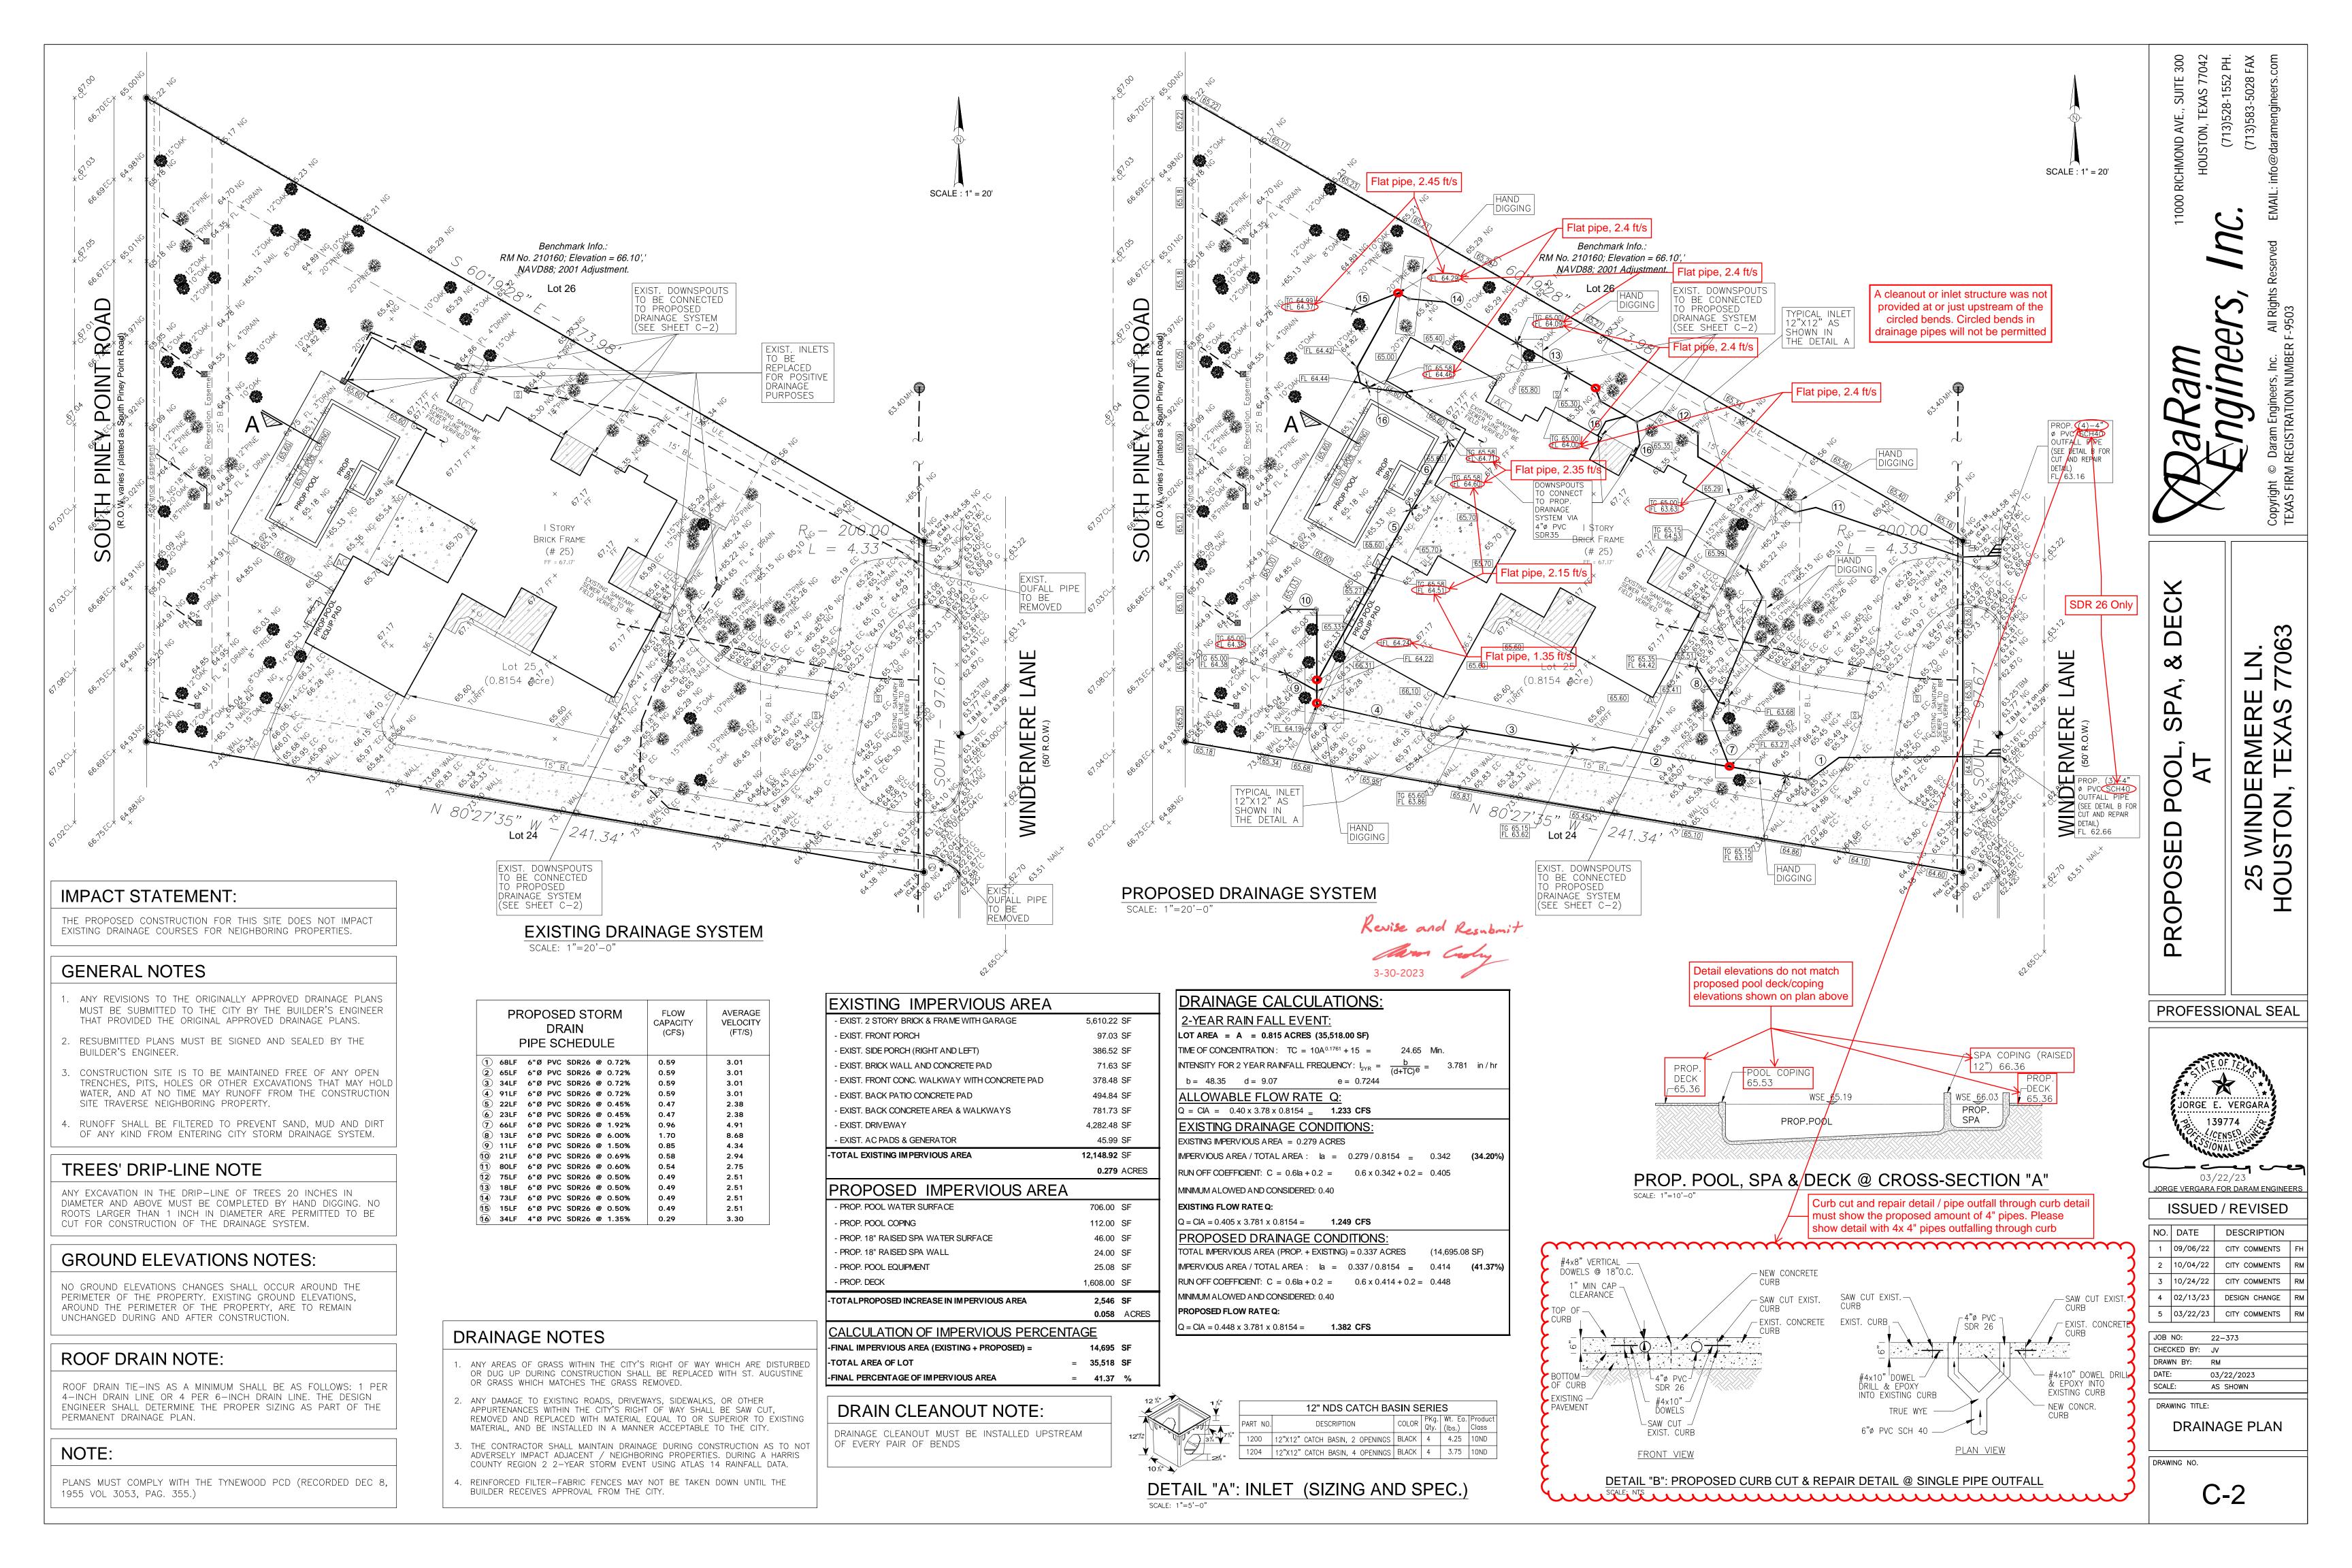

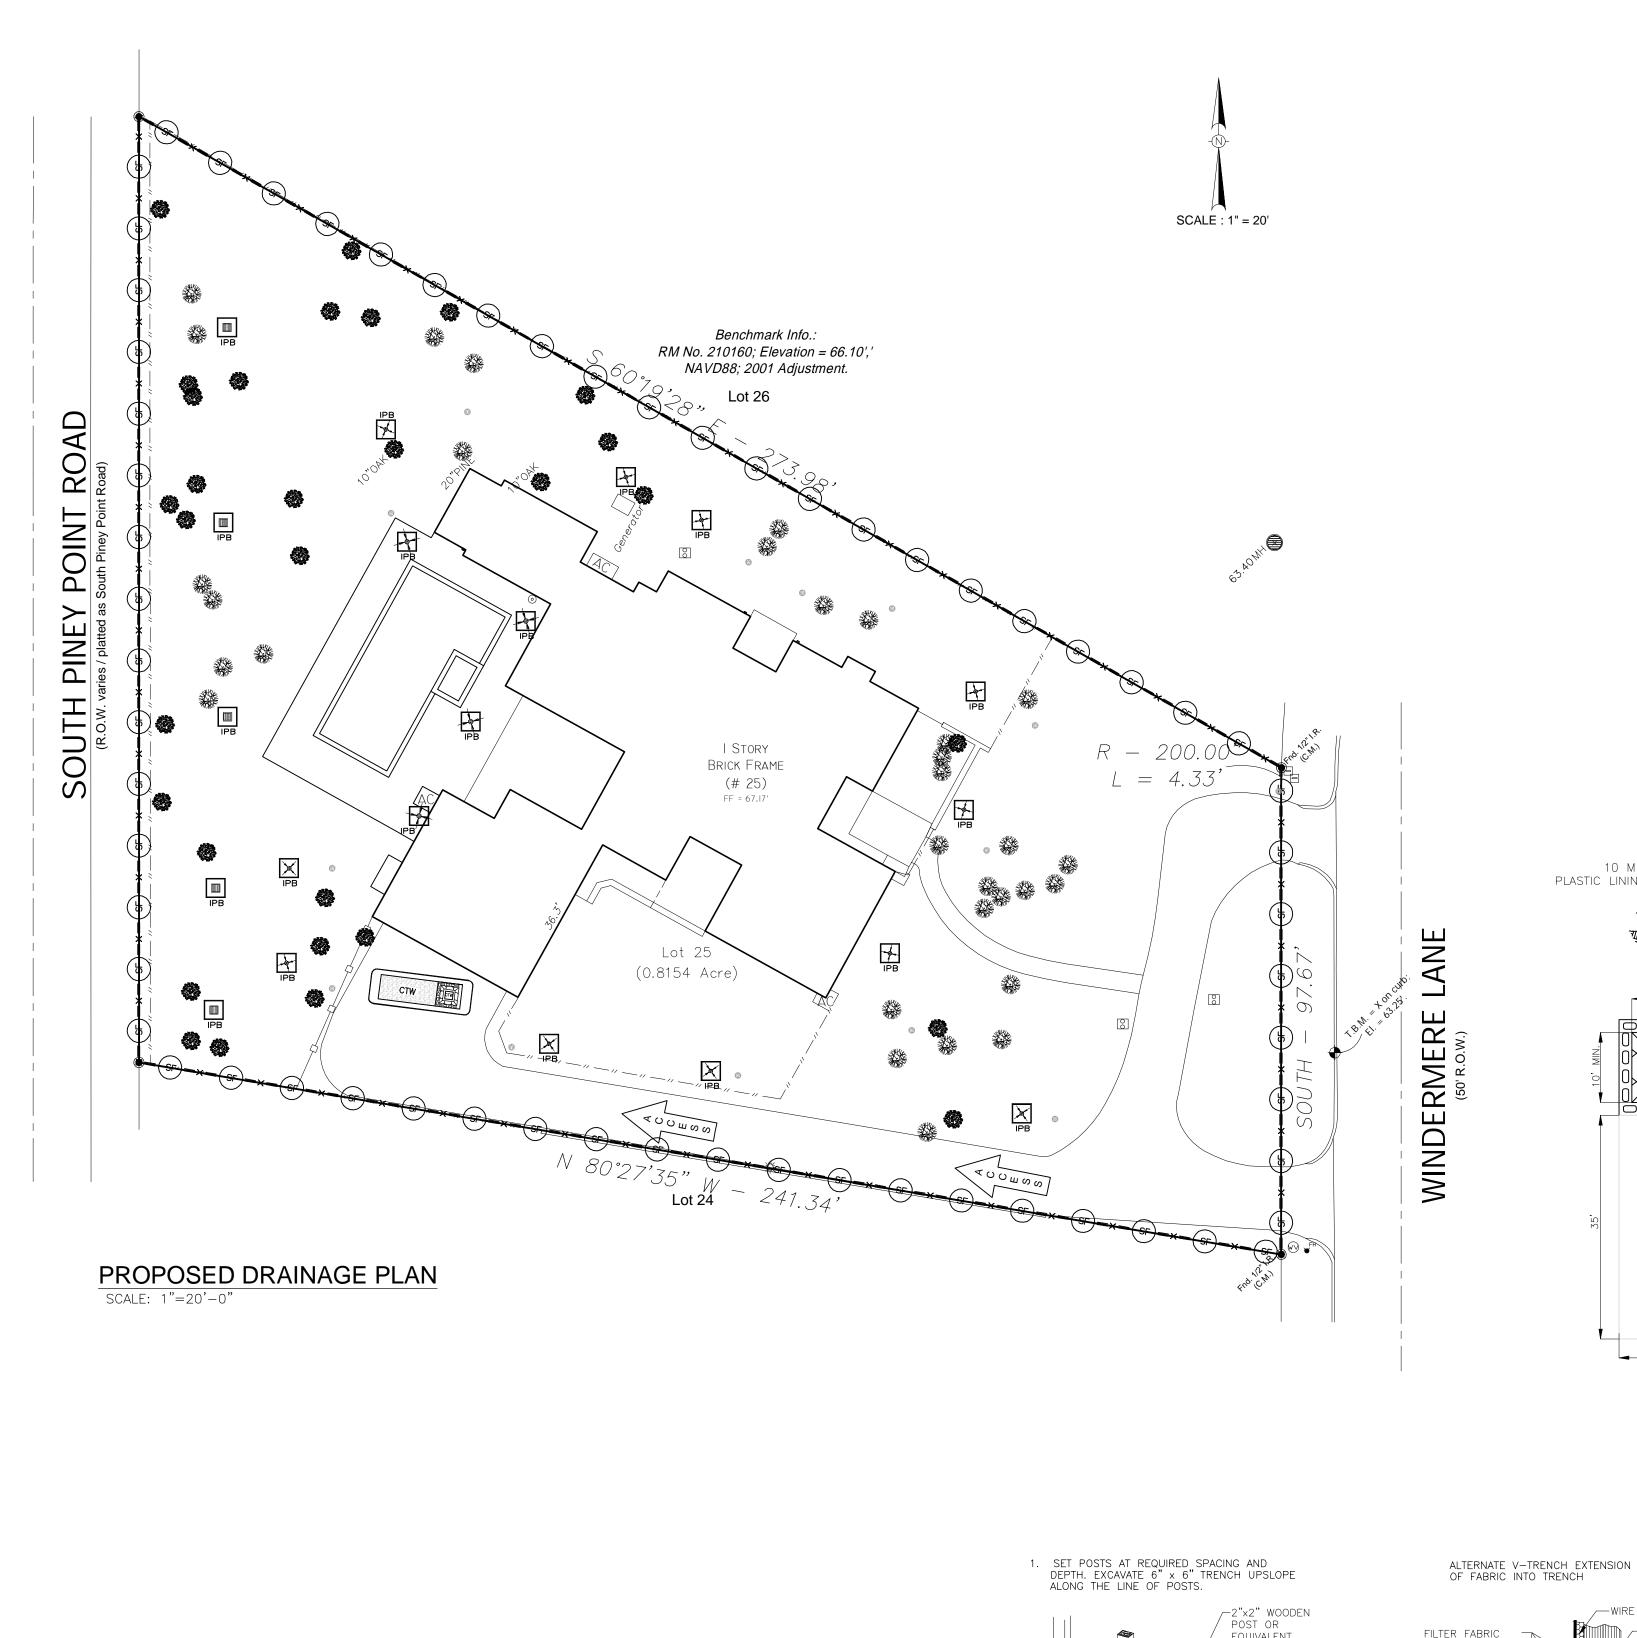

EXCAVATION ACCESS

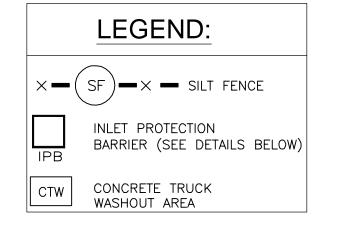


GROUND ELEVATIONS NOTES:

NO GROUND ELEVATIONS CHANGES SHALL OCCUR AROUND THE PERIMETER OF EXISTING GROUND ELEVATIONS, AROUND THE PERIMETER OF THE PROPERTY, ARE TO REMAIN UNCHANGED DURING AND AFTER CONSTRUCTION.

TREES' DRIP-LINE NOTE

ANY EXCAVATION IN THE DRIP-LINE OF TREES 20 INCHES IN DIAMETER AND ABOVE MUST BE COMPLETED BY HAND DIGGING. NO ROOTS LARGER THAN 1 INCH IN DIAMETER ARE PERMITTED TO BE CUT FOR CONSTRUCTION OF THE DRAINAGE SYSTEM.

CONTRACTOR TO PROVIDE SUMP PUMP DURING POOL CAVITY EXCAVATION AND DRAIN THROUGH EXISTING INLET.

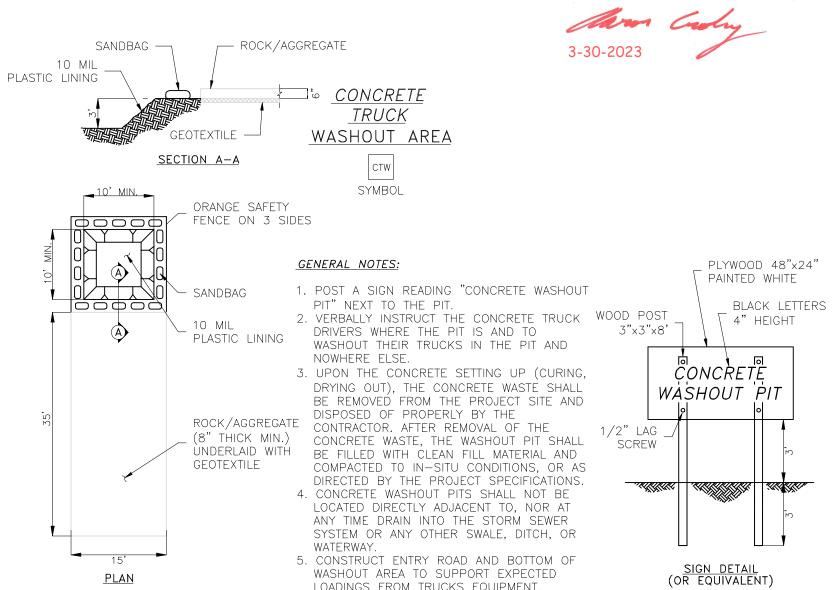



CONCRETE TRUCK WASHOUT (CTW) AREA SCALE: N.T.S


3. ATTACH FILTER MATERIAL TO WIRE FENCE AND EXTEND IT INTO THE TRENCH. BACKFILL AND


COMPACT THE EXCAVATED SOIL.

GENERAL NOTES:

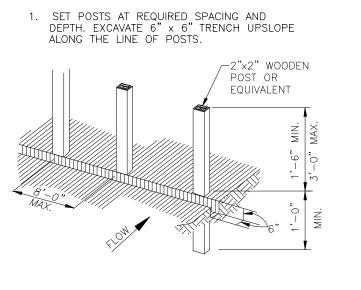


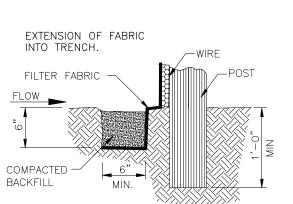

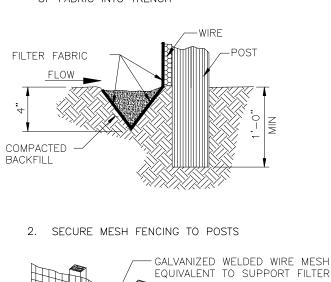

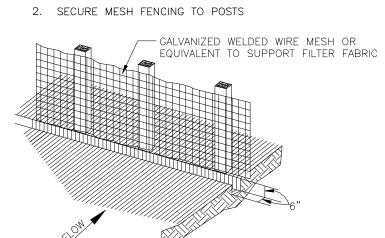

S.W.P.P.P. DETAILS

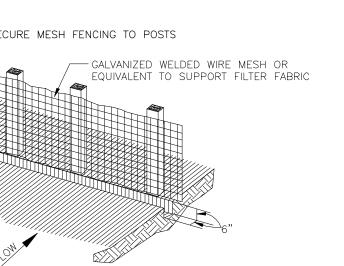

REINFORCED FILTER FABRIC BARRIER

3. WHEN TWO SECTIONS OF FILTER FABRIC ADJOIN EACH OTHER, OVERLAP 6 INCHES AT A

4. REMOVE SEDIMENT DEPOSITS WHEN SILT REACHES ONE-THIRD OF THE HEIGHT OF THE

1. SECURELY FASTEN MESH FENCING TO POSTS WITH STAPLES OR TIE WIRES.

2. SECURELY FASTEN FILTER FABRIC TO MESH FENCING.

POST, FOLD TOGETHER, AND ATTACH TO A POST.

EROSION CONTROL SYSTEM NOTES

THE CONTRACTOR IS RESPONSIBLE FOR PROVIDING SILT FENCES TO PREVENT EROSION FROM REACHING ADJACENT PROPERTY.

IN THE EVENT THE PREVENTION MEASURES ARE NOT EFFECTIVE, THE CONTRACTOR SHALL REMOVE ANY EROSION DEBRIS AND RESTORE ADJACENT PROPERTY AND/OR

RIGHT-OF-WAY TO ORIGINAL OR BETTER CONDITION. EROSION CONTROL FEATURES SHOWN ARE THE MINIMUM REQUIREMENTS ACCEPTABLE. PLACE ADDITIONAL EROSION CONTROL DEVICES AS RUNOFF AND DRAINAGE PATTERNS

CHANGE DURING CONSTRUCTION TO PROHIBIT LOST OF SOIL FROM THE SITE. MINIMIZE THE AMOUNT OF SURFACE AREA EXPOSED TO THE EXTENT PRACTICABLE. LEAVE GRADED AREAS WITH A ROUGH TEXTURE TO PROMOTE INFILTRATION. LIMIT

INSTALL SILT FENCES IN DOWNSTREAM SLOPES FOR THE EXTENT OF THE CONSTRUCTION LIMITS PRIOR TO BAGGING ANY GRADING OPERATIONS.

A- INSTALL SILT FENCES AT LOCATIONS SHOWN GENERALLY ALONG THE CONTOUR OF DOWNSTREAM SLOPES.

B- INSTALL POST-ANGLING SLIGHTLY UPSTREAM. USE WIRE FENCE AND SPACE POST AT 10' TO SUPPORT FABRIC.

C- EXCAVATE 4" x 4" TRENCH ON UPSTREAM SITE, EMBED FABRIC 8", BACKFILL TRENCH AND COMPACT.

D- FASTEN FABRIC AND WIRE FENCE SECURELY TO POSTS.

UNNECESSARY TRAFFIC ON GRADED AREAS.

REMEDY THE PROBLEM.

A LEGALLY APPROVED MANNER.

E- REINFORCED FILTER FABRIC FENCES MAY NOT BE TAKEN DOWN UNTIL THE BUILDER RECEIVES APPROVAL FROM THE CITY.

MAINTAIN EROSION CONTROL DEVICES IN GOOD CONDITION AT ALL TIMES. INSPECT FREQUENTLY AND AFTER EACH RAINFALL

REDISTRIBUTE ACCUMULATED SEDIMENT UPSTREAM OF DEVICES.

REMOVE EROSION CONTROL DEVICES WHEN NO LONGER NEEDED. PROPERLY DISPOSE OF SOLID WASTE, PAINTS, SOLVENTS, CLEANING COMPOUNDS, ETC.

STORE CONSTRUCTION MATERIAL AWAY FROM LOW AREAS AND DRAINAGE WAYS. PROVIDE PORTABLE TOILETS AND PROPERLY DISPOSE OF SANITARY SEWAGE. PROVIDE MINIMUM TWO ADJACENT TO TEMPORARY CONSTRUCTION TRAILER.

LOCATE FUEL/MATERIAL STORAGE AREAS AWAY FROM STORM WATER CONVEYANCE SYSTEMS. USE A LINER UNDER ABOVE GROUND STORAGE TANKS. USE SILT FENCING AROUND FUEL STORAGE AREAS. (NO SEPARATE PAY).

CONTRACTOR WILL ADVICE OWNER IMMEDIATELY, VERBALLY, AND IN WRITING, OF ANY FUEL SPILLS ONTO THE PROJECT/CONSTRUCTION AREAS AND THE ACTION TAKEN TO

CONTRACTOR IS RESPONSIBLE FOR COMPLYING WITH ALL ENVIRONMENTAL LOSS. CONTRACTOR IS RESPONSIBLE FOR DISPOSING FUELS, MATERIALS, AND EXCAVATIONS IN

CONTRACTOR IS TO INSPECT ALL STRUCTURAL CONTROLS SPECIFIED HEREIN, AT A MINIMUM, ONCE EVERY SEVEN CALENDAR DAYS OR BETWEEN 24 HOURS AFTER EVERY STORM EVENT THAT MEETS OR EXCEEDS 0.5 INCHES/24 HOUR PERIOD.

CONTRACTOR WILL PROVIDE STORAGE AREAS FOR CHEMICAL, PAINTS. SOLVENTS, FERTILIZERS, AND ANY POTENTIALLY TOXIC MATERIAL.


FILTER FABRIC (SILT FENCE) FLOW RATE WILL BE 30 GALLON PER SQUARE FOOT PER

FILTER FABRIC WILL BE STAPLED OVER BOARDS ON ALL STAGE ONE STORM SEWER

PROTECT ALL DESIGNATED SPECIMEN TREES WITH PROTECTIVE FENCING.

TEMPORARY DRAINAGE NOTES

- ANY AREAS OF GRASS WITHIN THE CITY'S RIGHT OF WAY WHICH ARE DISTURBED OR DUG UP DURING CONSTRUCTION SHALL BE REPLACED WITH ST. AUGUSTINE OR GRASS WHICH MATCHES THE GRASS REMOVED.
- 2. ANY DAMAGE TO EXISTING ROADS, DRIVEWAYS, SIDEWALKS, OR OTHER APPURTENANCES WITHIN THE CITY'S RIGHT OF WAY SHALL BE SAW CUT, REMOVED AND REPLACED WITH MATERIAL EQUAL TO OR SUPERIOR TO EXISTING MATERIAL, AND BE INSTALLED IN A MANNER ACCEPTABLE TO THE
- 3. THE CONTRACTOR SHALL MAINTAIN DRAINAGE DURING CONSTRUCTION AS TO NOT ADVERSELY IMPACT ADJACENT / NEIGHBORING PROPERTIES DURING A HARRIS COUNTY REGION 2 2-YEAR STORM EVENT USING ATLAS 14 RAINFALL DATA.
- I. REINFORCED FILTER-FABRIC FENCES MAY NOT BE TAKEN DOWN UNTIL THE BUILDER RECEIVES APPROVAL FROM THE CITY.

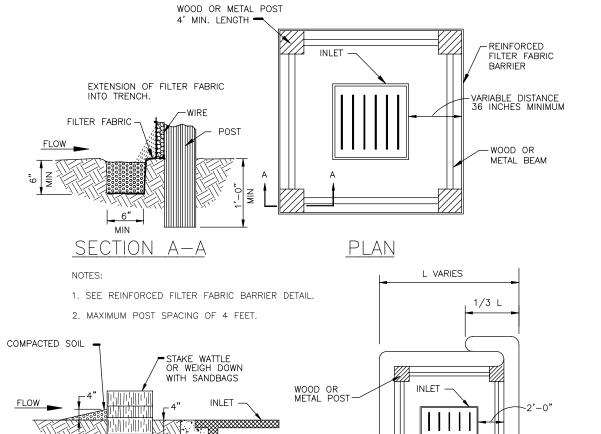

SECTION A-A

WATTLE STAKED
WITH 2 STAKES PER
BALE OR WEIGHTED
WITH SANDBAGS

HAY BALES ARE NOT ALLOWED FOR INLET PROTECTION BARRIERS.

INLET PROTECTION BARRIERS FOR STAGE | INLETS



5 03/22/23 CITY COMMENTS R JOB NO: 22-373 CHECKED BY: JV DRAWN BY: RM 03/22/2023 SCALE: AS SHOWN DRAWING TITLE:

SWPPP

DRAWING NO.

907

R

IDERMER N, TEXA

PROFESSIONAL SEAL

JORGE E. VERGARA 139774

JORGE VERGARA FOR DARAM ENGINEERS

ISSUED / REVISED

1 09/06/22 CITY COMMENTS

2 | 10/04/22 | CITY COMMENTS | F

3 | 10/24/22 | CITY COMMENTS | R

4 02/13/23 DESIGN CHANGE R

NO. DATE DESCRIPTION

25 OU

∞

